



ROOF FRAMING PLAN
SCALE: 1/8"=1'-0"


- NOTES:
 1. REFER TO ARCHITECTURAL DRAWINGS FOR INTERIOR WALL LAYOUT DIMENSIONS.
 2. ALL ROOF FRAMING TO BE @ 24"/c U.N.O.
 3. ROOF SHEATHING SHALL BE 5/8" T&G ADVANTECH SHEATHING BY HUBER WOODS (NAILED W/RING SHANK NAILS)
 4. T.O.S. ELEVATION=1913'-0"
 5. ALL WALLS SHOWN ON THIS PLAN ARE LOCATED "BELOW" THIS FRAMING LEVEL, U.N.O.
 6. SHADED AREAS INDICATE 24"/c FRAMING OVERBUILD ON ROOF BELOW. FRAME OVERBUILD AT SMALL DORMERS W/2x8 FRAMING. FRAME OVERBUILD AT CENTER OF BUILDING WITH STEPPED ROOF TRUSSES.
 7. ALL STEEL BEAMS & COLUMNS SHALL BE FIRE-PROOFED IN ACCORDANCE TO UL ASSEMBLY X829 (1 HR) OR APPROVED EQUIVALENT (REF. DETAIL 1/A-810)
 8. = MOMENT CONNECTION

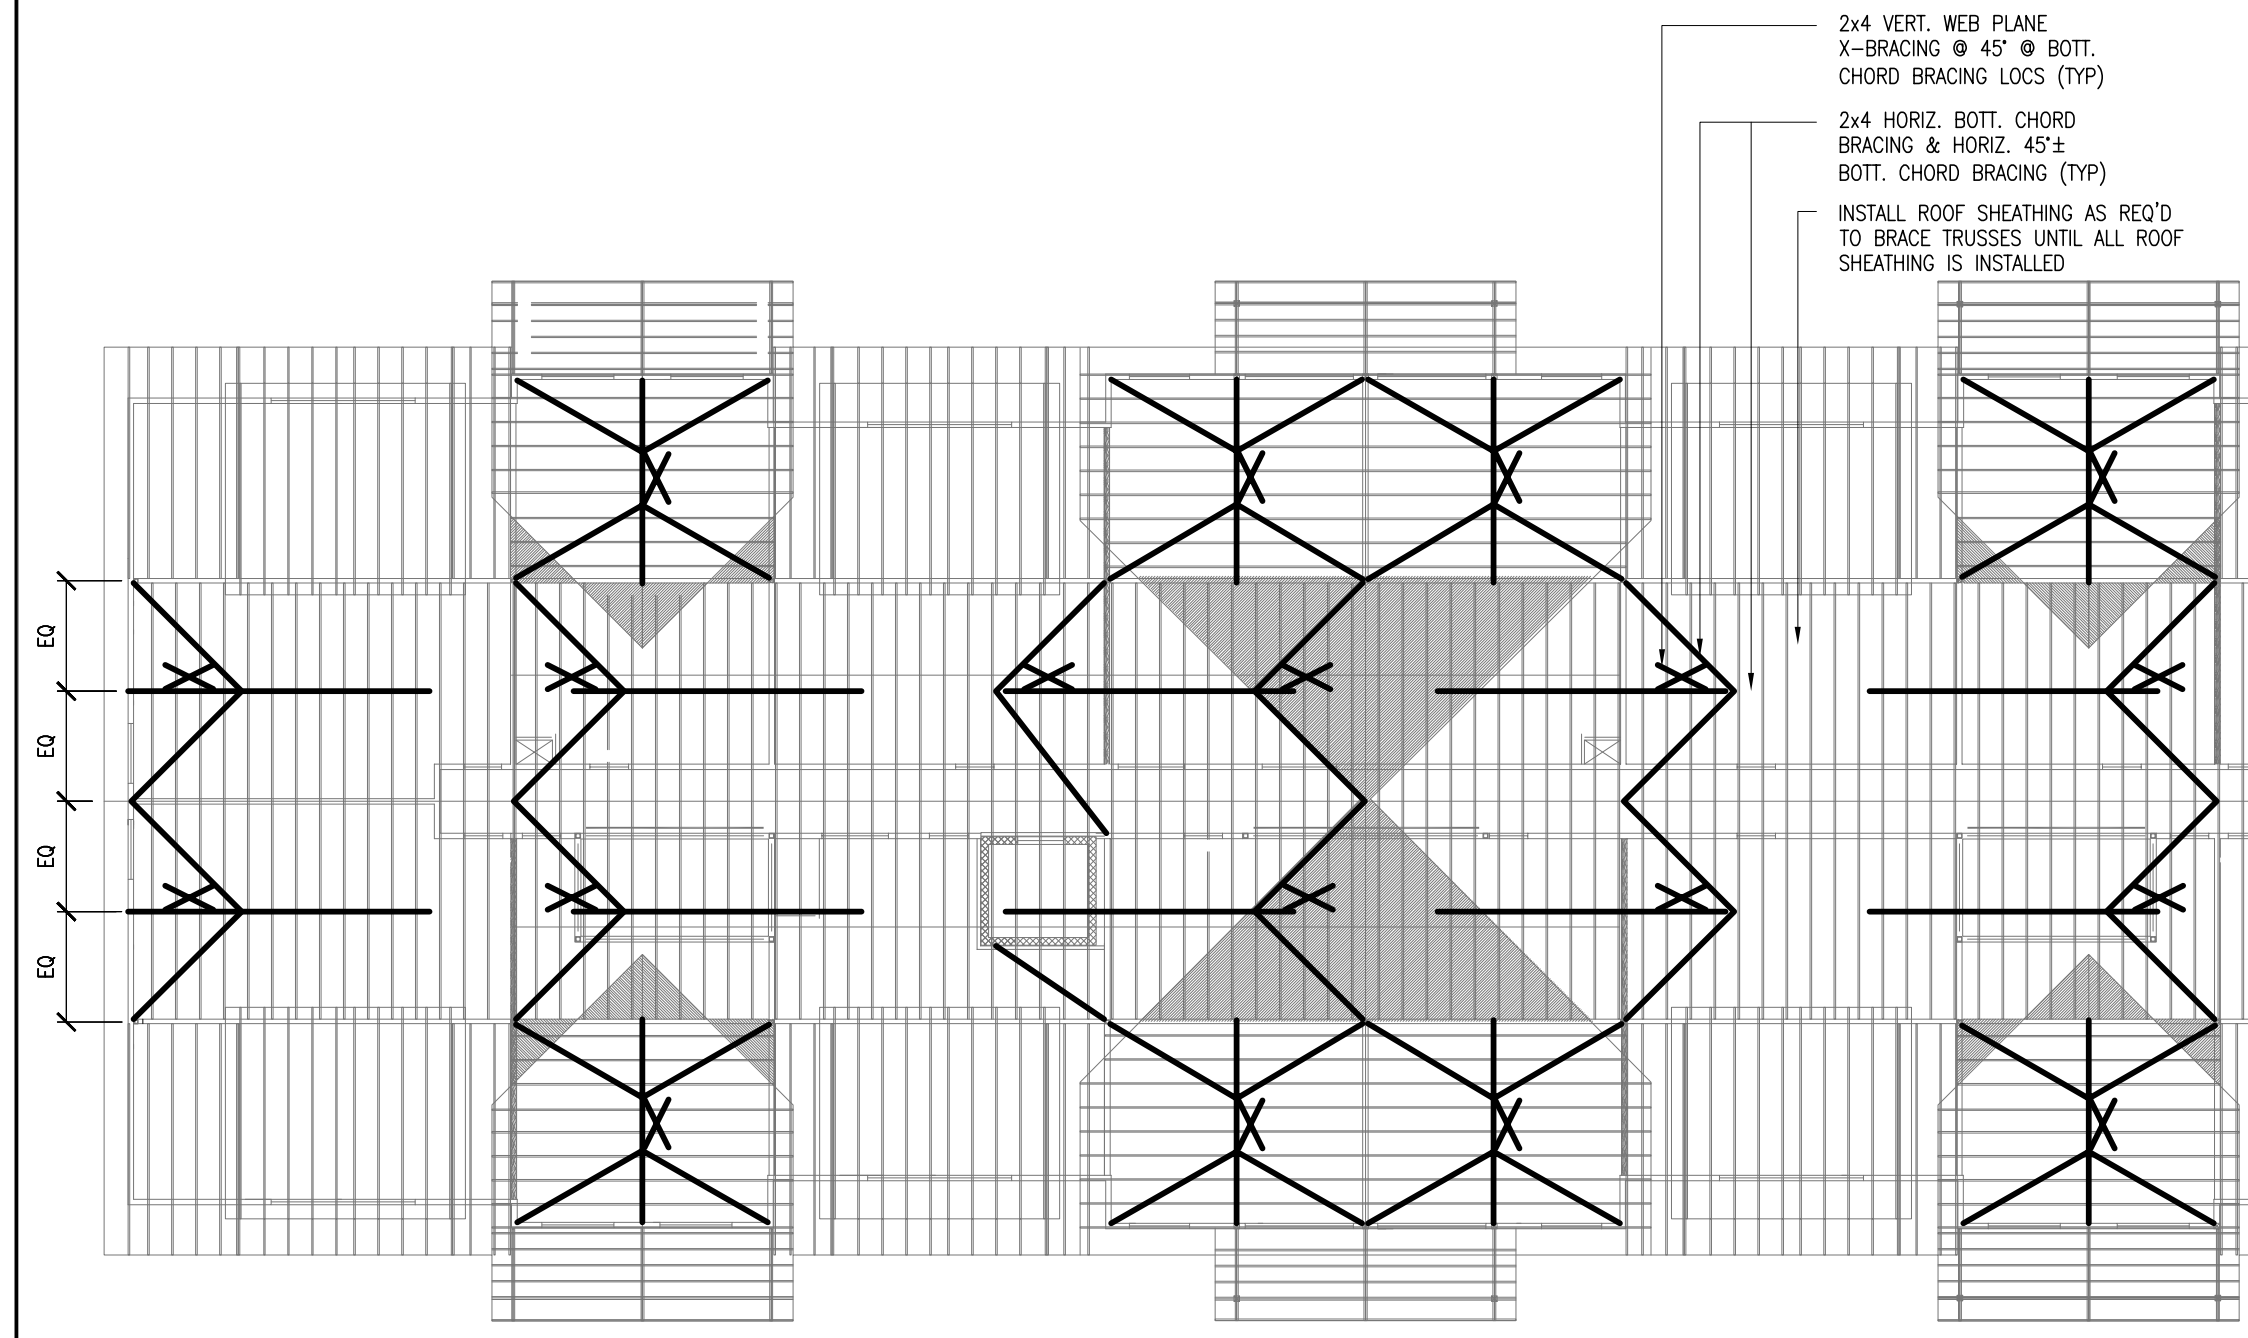

ROOF TRUSS BRACING PLAN
SCALE: 1/8"=1'-0"

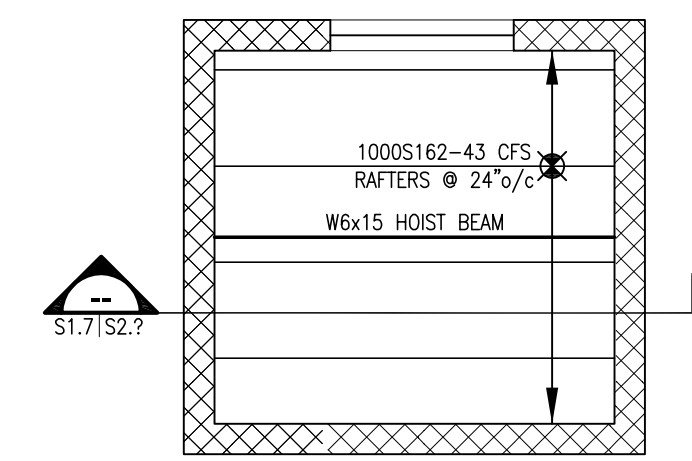

DETAIL
S1.7/S1.7.1 SCALE: 1/2"=1'-0"

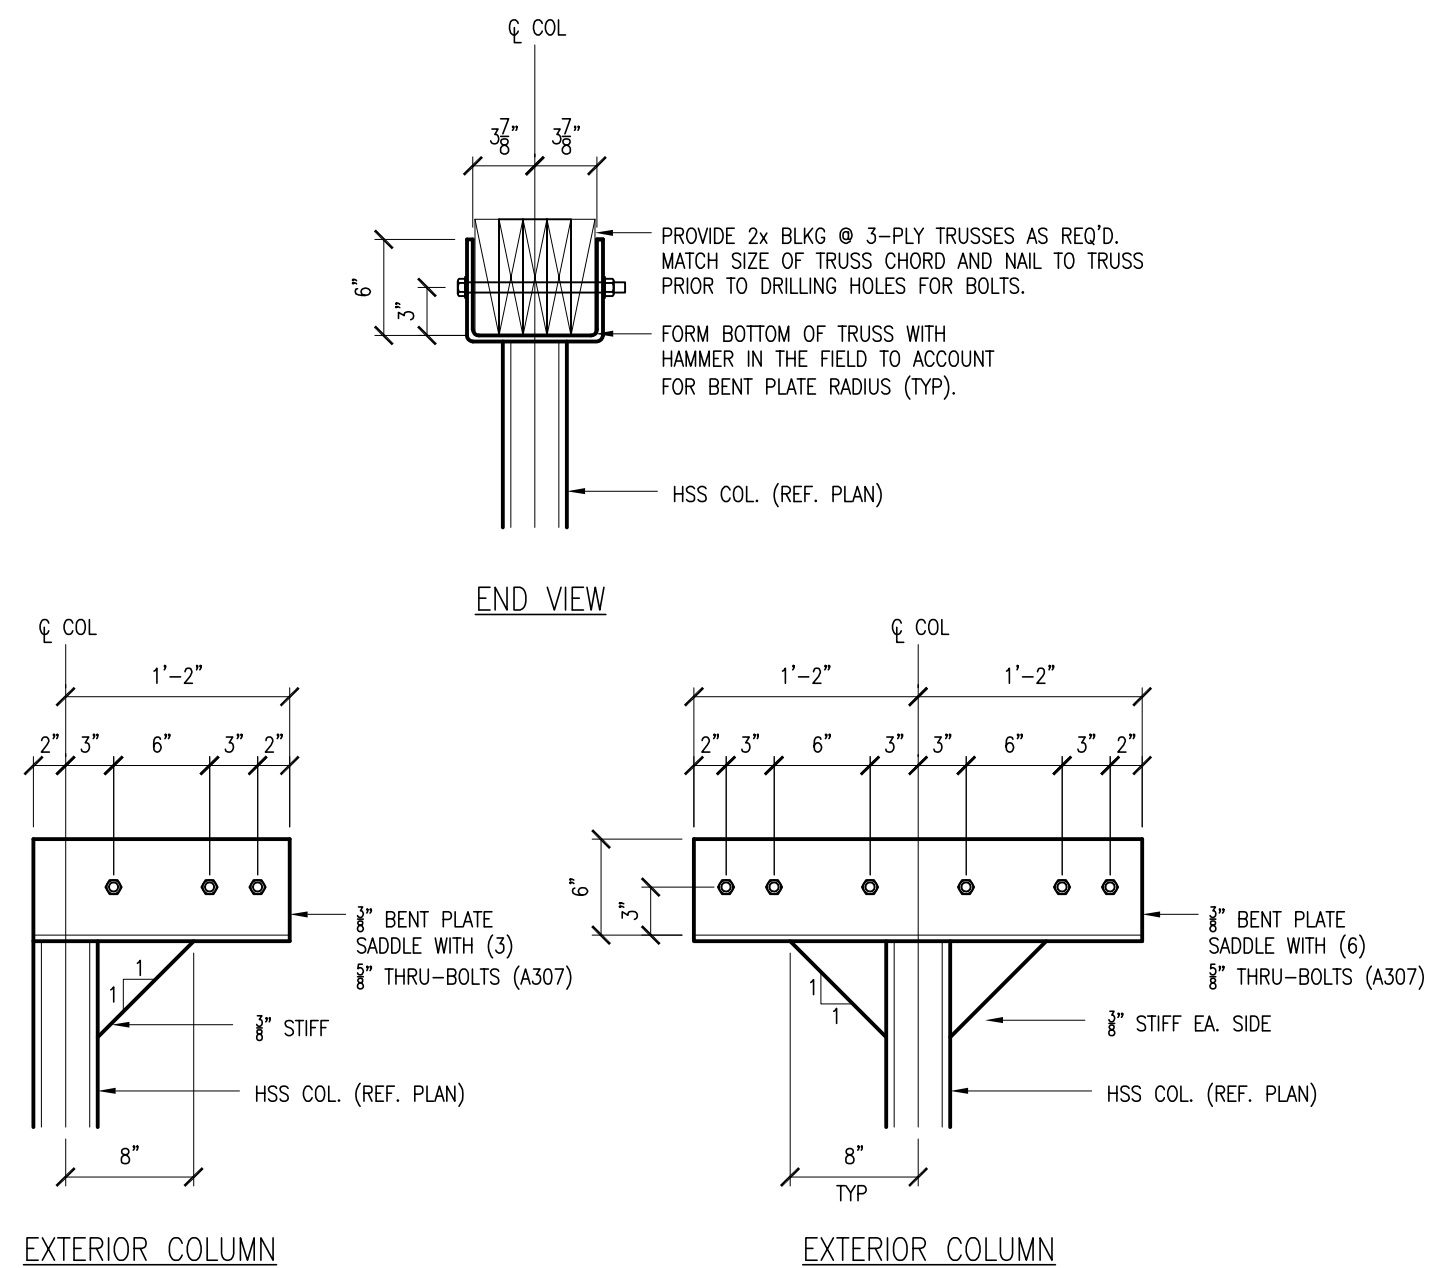

GIRDER TRUSS SUPPORT BRACKET DETAILS
SCALE: 1/2"=1'-0"

- Notes générales / General notes :**
1. These architectural documents are the exclusive property of DCYSM Architecture + Design and cannot be used, copied or reproduced without written pre-authorization.
 2. All dimensions which appear on the documents must be verified by the contractor before to start the work.
 3. The architect must be notified of all errors, omissions and discrepancies between these documents and those of the other professionals.
 4. The dimensions on these documents must be read and not measured.
-
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 Fax: 802.257.2700
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 VT 05409
 Phone: 802.658.2446
 Fax: 802.658.3446
- Leach Engineering**
 38 Eastern Avenue, Suite 6
 St. Johnsbury, VT 05819
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 Fax: 802.748.8200
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NO	DATE	REVISION

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PROJECT / PROJET
HOTEL ONE Jay Peak, Vermont

NO. PROJET / PROJECT NUMBER
 5192

TITRE DU DESSIN / DRAWING TITLE
STRUCTURAL ROOF FRAMING PLAN

DATE 04.10.08	DESSINÉ PAR / DRAWN BY SMD
ECHELLE / SCALE AS NOTED	VÉRIFIÉ PAR / CHECKED BY TPH
NO DESSIN / DWG. NUMBER S1.7	REVISION 2