



FRONT ENTRY DETAIL
S3-01S3-01 SCALE: 1/4"=1'-0"

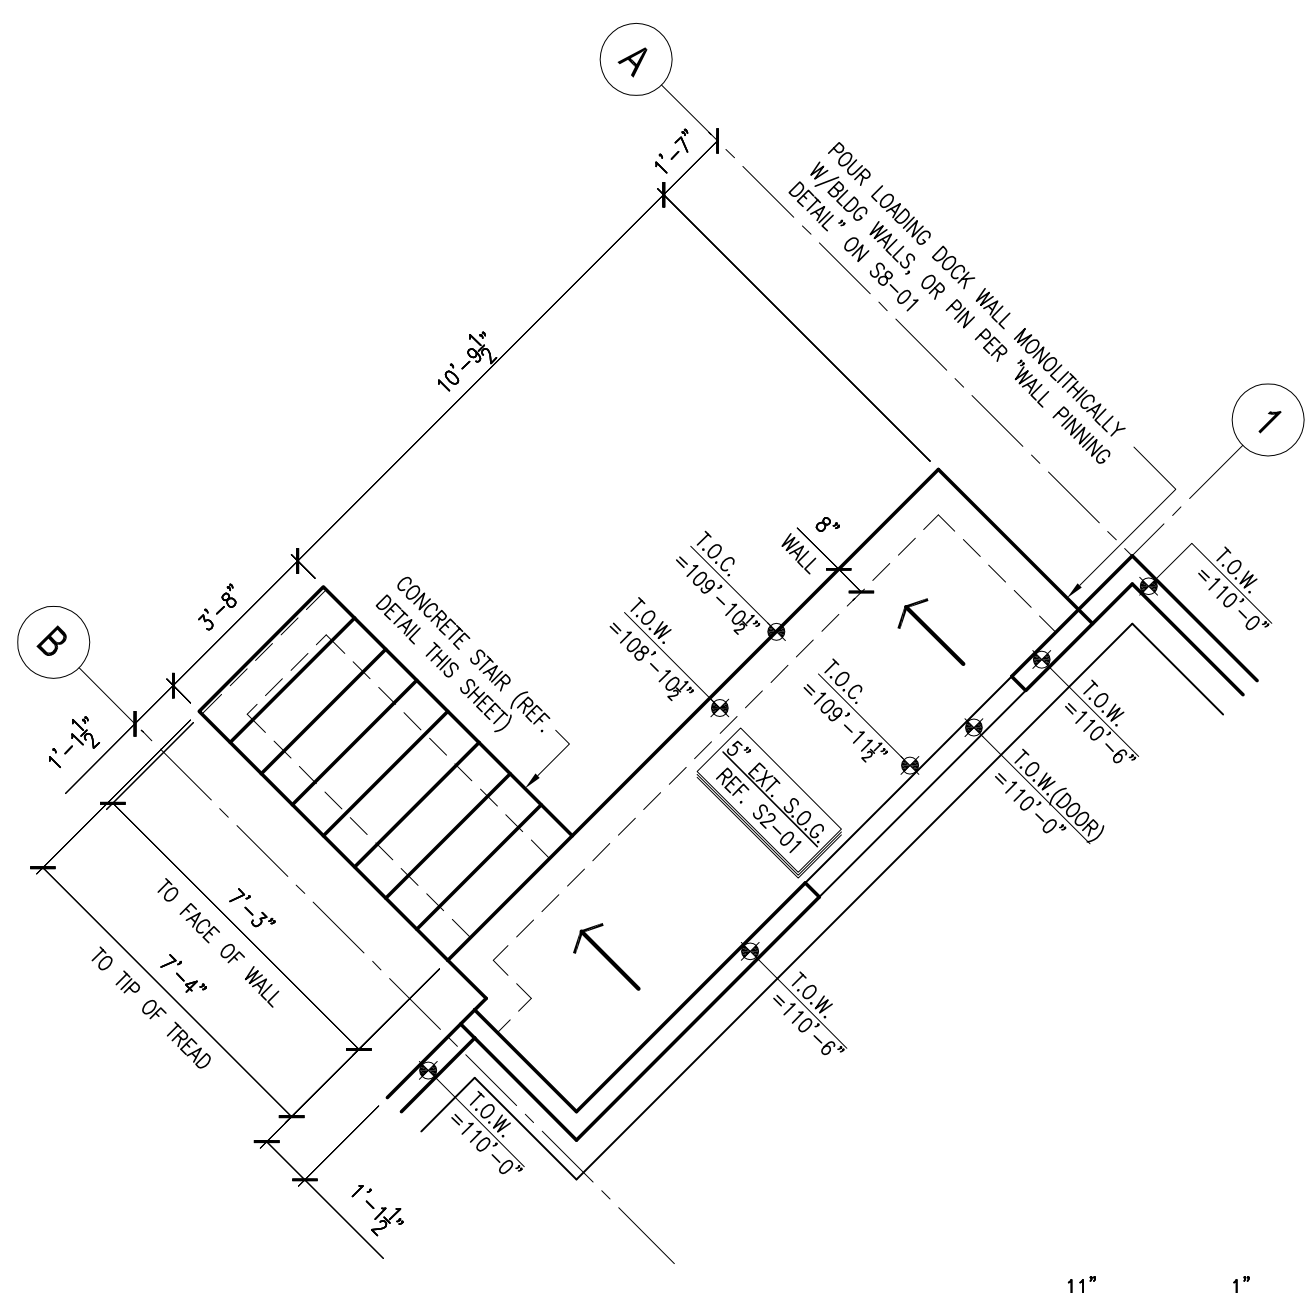

LOADING DOCK DETAIL
S3-01S3-01 SCALE: 1/4"=1'-0"

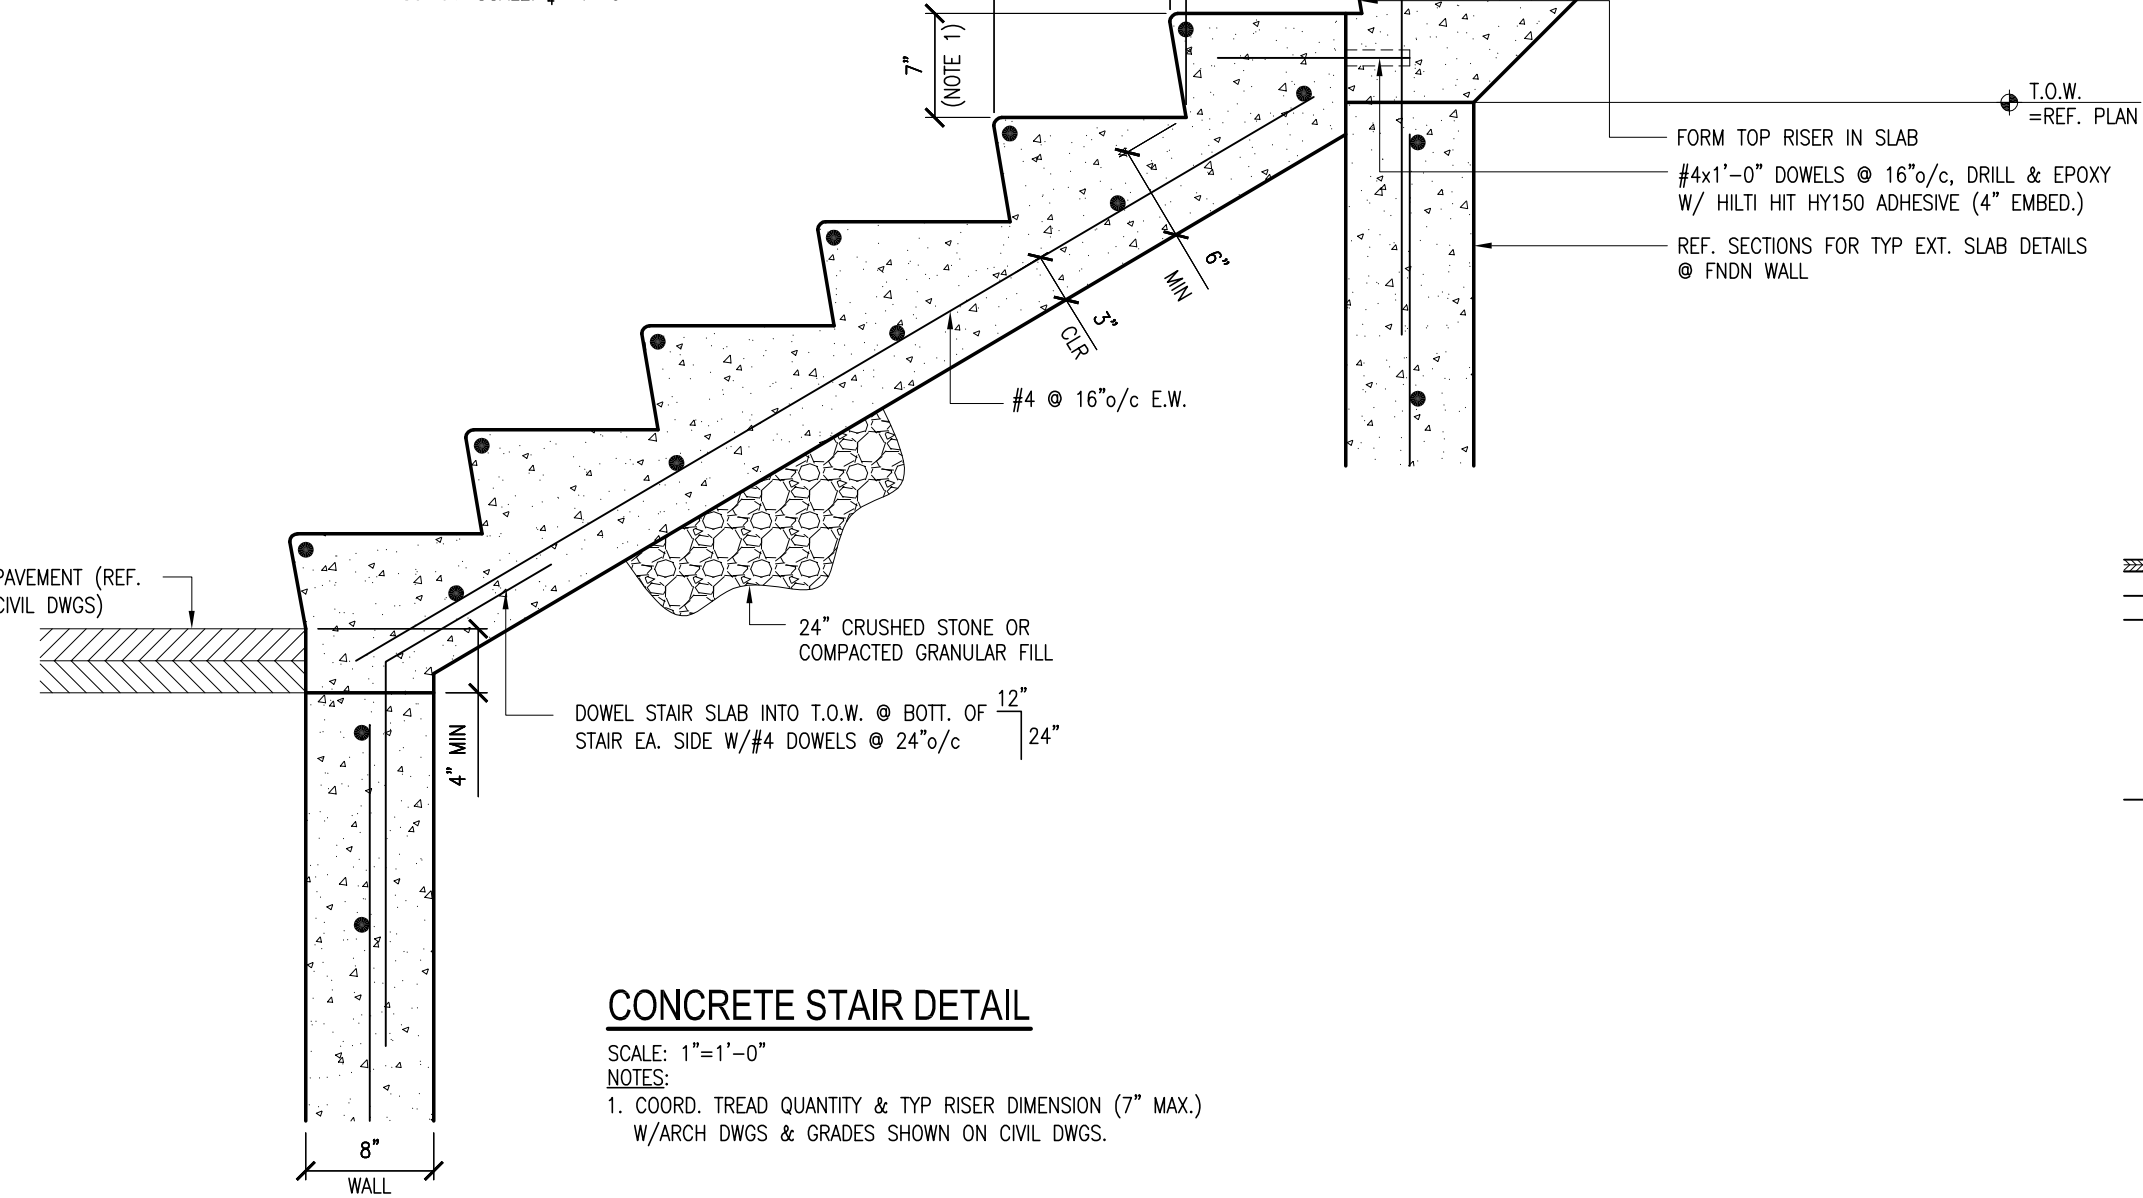


CONCRETE STAIR DETAIL
SCALE: 1/4"=1'-0"

NOTES:
1. COORD. TREAD QUANTITY & TYP. RISER DIMENSION (7" MAX.) W/ARCH DWGS & GRADES SHOWN ON CIVIL DWGS.


LEVEL 3 FRAMING PLAN (ZONE 1)
SCALE: 1/4"=1'-0"

- NOTES:
- REFER TO ARCHITECTURAL DRAWINGS FOR INTERIOR WALL LAYOUT DIMENSIONS.
 - ALL FLOOR FRAMING SHALL BE @ 16"/c U.N.D. (STUDS AND TRUSSES SHALL BE ON THE SAME LAYOUT U.N.D.)
 - FLOOR SHEATHING SHALL BE 7/8" TAG ADVANTECH SHEATHING BY HUBER WOODS (GLUED & NAILED W/RING SHANK NAILS). TOP OF SHEATHING ELEVATION=109'-1 1/2"
 - ALL WALLS SHOWN ON THIS PLAN ARE LOCATED "BELOW" THIS FRAMING LEVEL.
 - PROVIDE MULTI-PLY TRUSSES AS REQ'D @ CHASES (COORD. SIZE & LOC. W/ARCH. DWGS)
 - ALL STEEL BEAMS AND COLUMNS ON THIS LEVEL TO RECEIVE SPRAY FIRE-PROOFING (1 HR.) PER ARCHITECTURAL DETAILS.
 - INDICATES PUBLIC AREAS TO BE DESIGNED FOR 100 PSF LIVE LOAD.
 - INDICATES KITCHEN AREAS TO BE DESIGNED FOR 150 PSF LIVE LOAD.
 - INDICATES BALCONY AREAS TO BE DESIGNED FOR LIVE LOAD TO MATCH OCCUPANCY SERVED (40 PSF FOR BALCONIES SERVING PRIVATE UNITS, 100 PSF FOR BALCONIES SERVING PUBLIC AREAS).
 - SIPS PANELS TO BE 10 1/2" THICK PANELS W/ DOUBLE 2x SPLINES (BY "R-CONTROL" OR APPROVED EQUIVALENT).

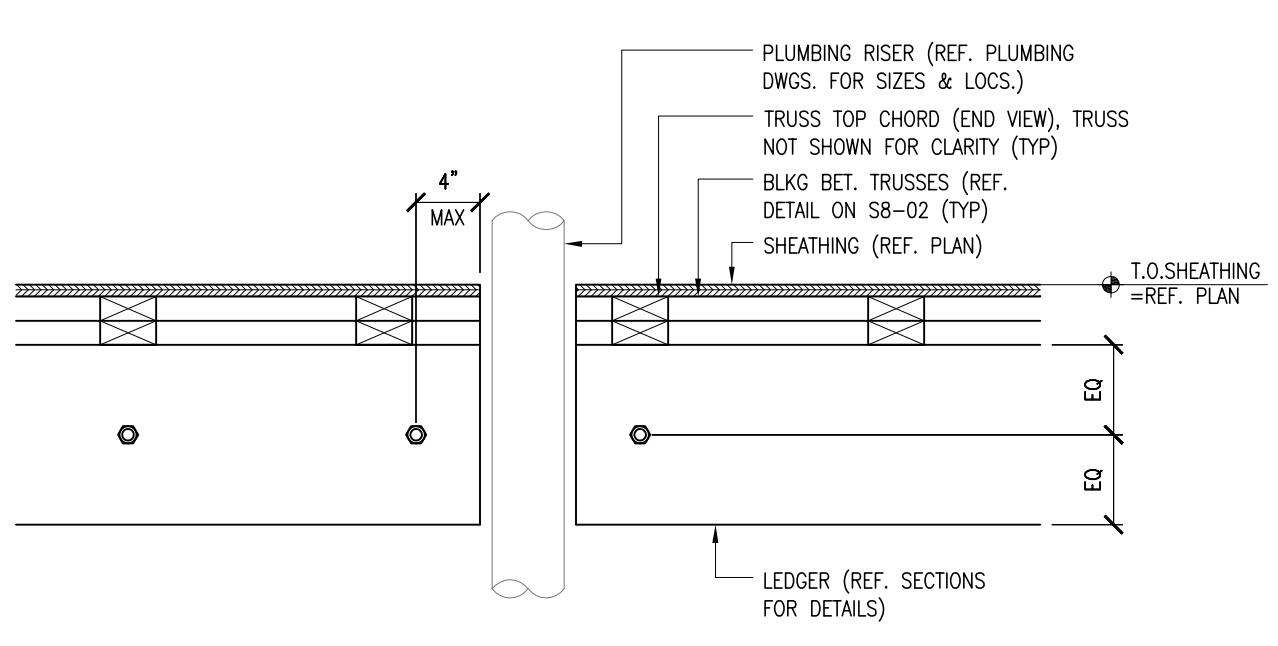


LEDGER DETAIL @ PLUMBING RISERS
SCALE: 1/4"=1'-0"

NOTES:
1. DETAIL APPLIES WHERE PLUMBING RISERS RUN ADJACENT TO CMU STAIR AND ELEVATOR SHAFT WALLS.

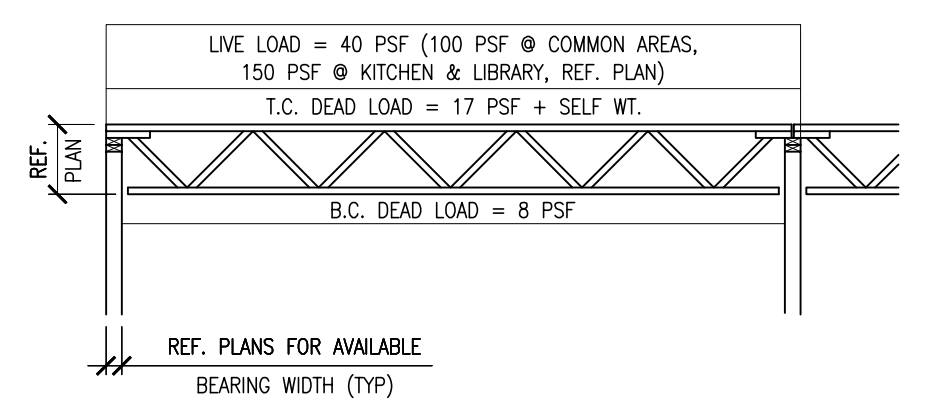


TYPICAL FLOOR TRUSS LOADING DIAGRAM
SCALE: N.T.S.


- NOTES:
- TRUSS DESIGNER TO DESIGN AND DETAIL STRONGBACKS AS REQ'D.
 - TOP CHORD SHALL BE ASSUMED TO BE FULLY BRACED BY SHEATHING.
 - LIVE LOAD DEFLECTION CRITERIA = SPAN/480 OR 1/2" MAX (WHICHEVER IS LESS).

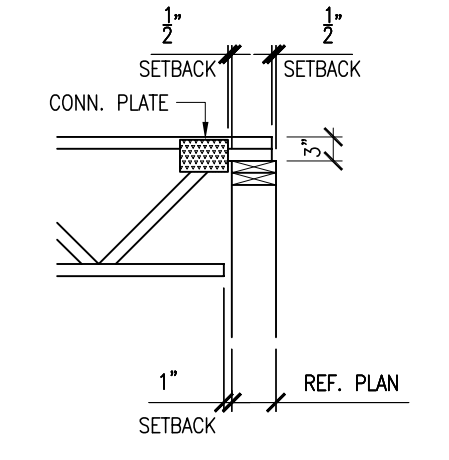

TYPICAL TRUSS SETBACKS
SCALE: N.T.S.

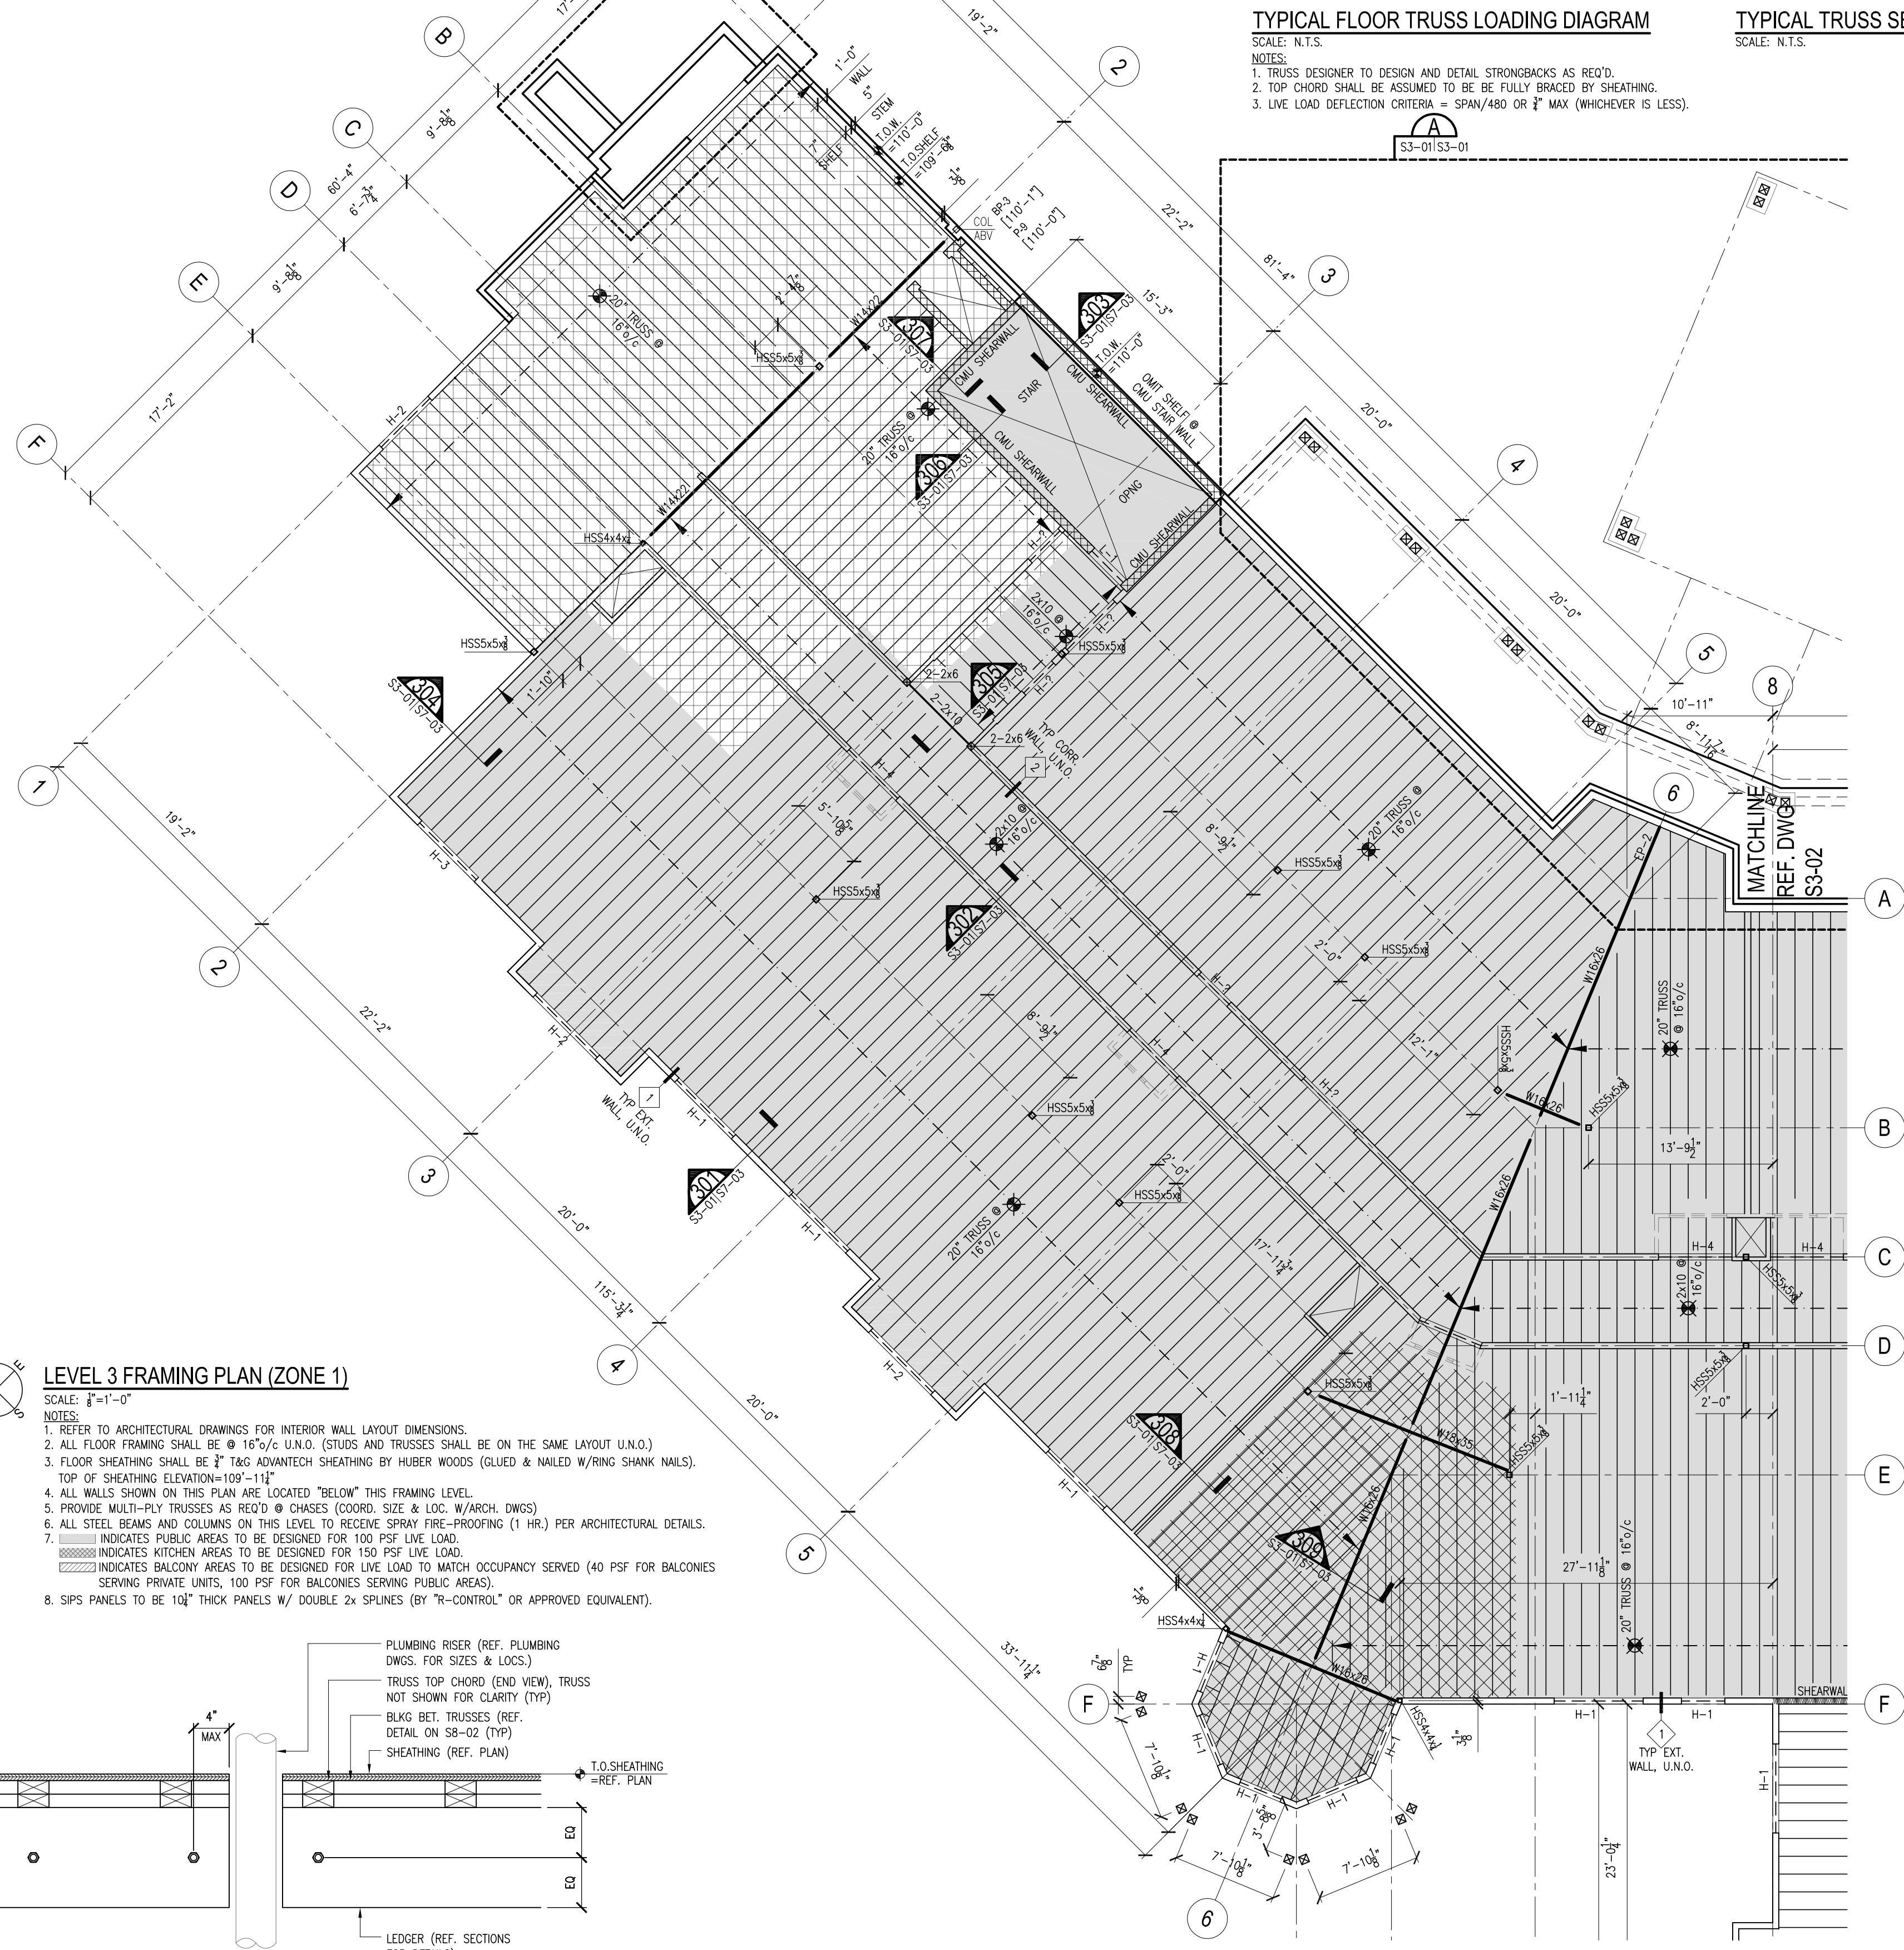

NOTES:

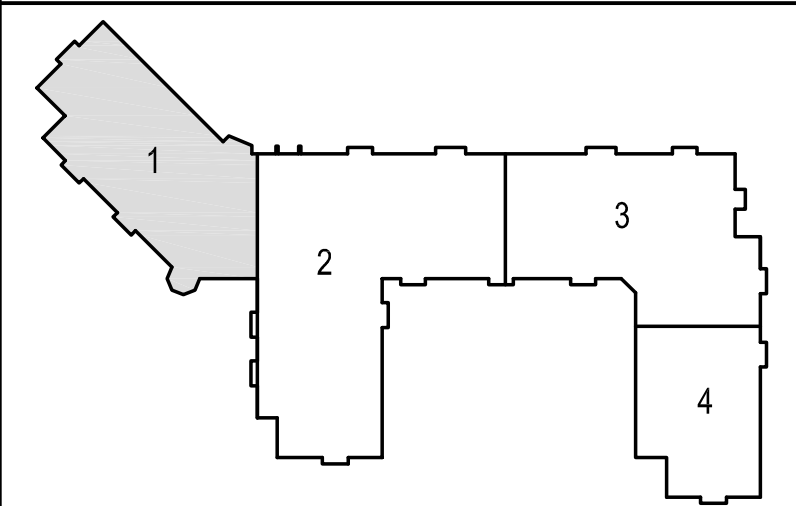

ALL DIMENSIONS TO BE VERIFIED AT THE SITE BY THE CONTRACTOR. ANY AND ALL ERRORS OR DISCREPANCIES MUST BE REFERRED TO THE ARCHITECT FOR DECISION BEFORE PROCEEDING WITH THE WORK IN QUESTION.

No.	DATE	REVISION NOTES
4	06.11.08	Issued for Construction
3	07.07.08	Issued for Permit
2	06.23.08	90% Progress Drawings
1	04.28.08	75% Progress Drawings



Project No.: HSE 06051.00
Project: WOODLANDS AT HARVEST HILL
LEBANON
NEW HAMPSHIRE
STRUCTURAL
LEVEL 3 FRAMING PLAN
ZONE 1

Scale: AS NOTED
Drawn By: S. DOUGHERTY
Checked By: T. HARDY

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